

DETAIL A
TYPICAL AUDITORIUM LIGHTING SECTION
NOT TO SCALE

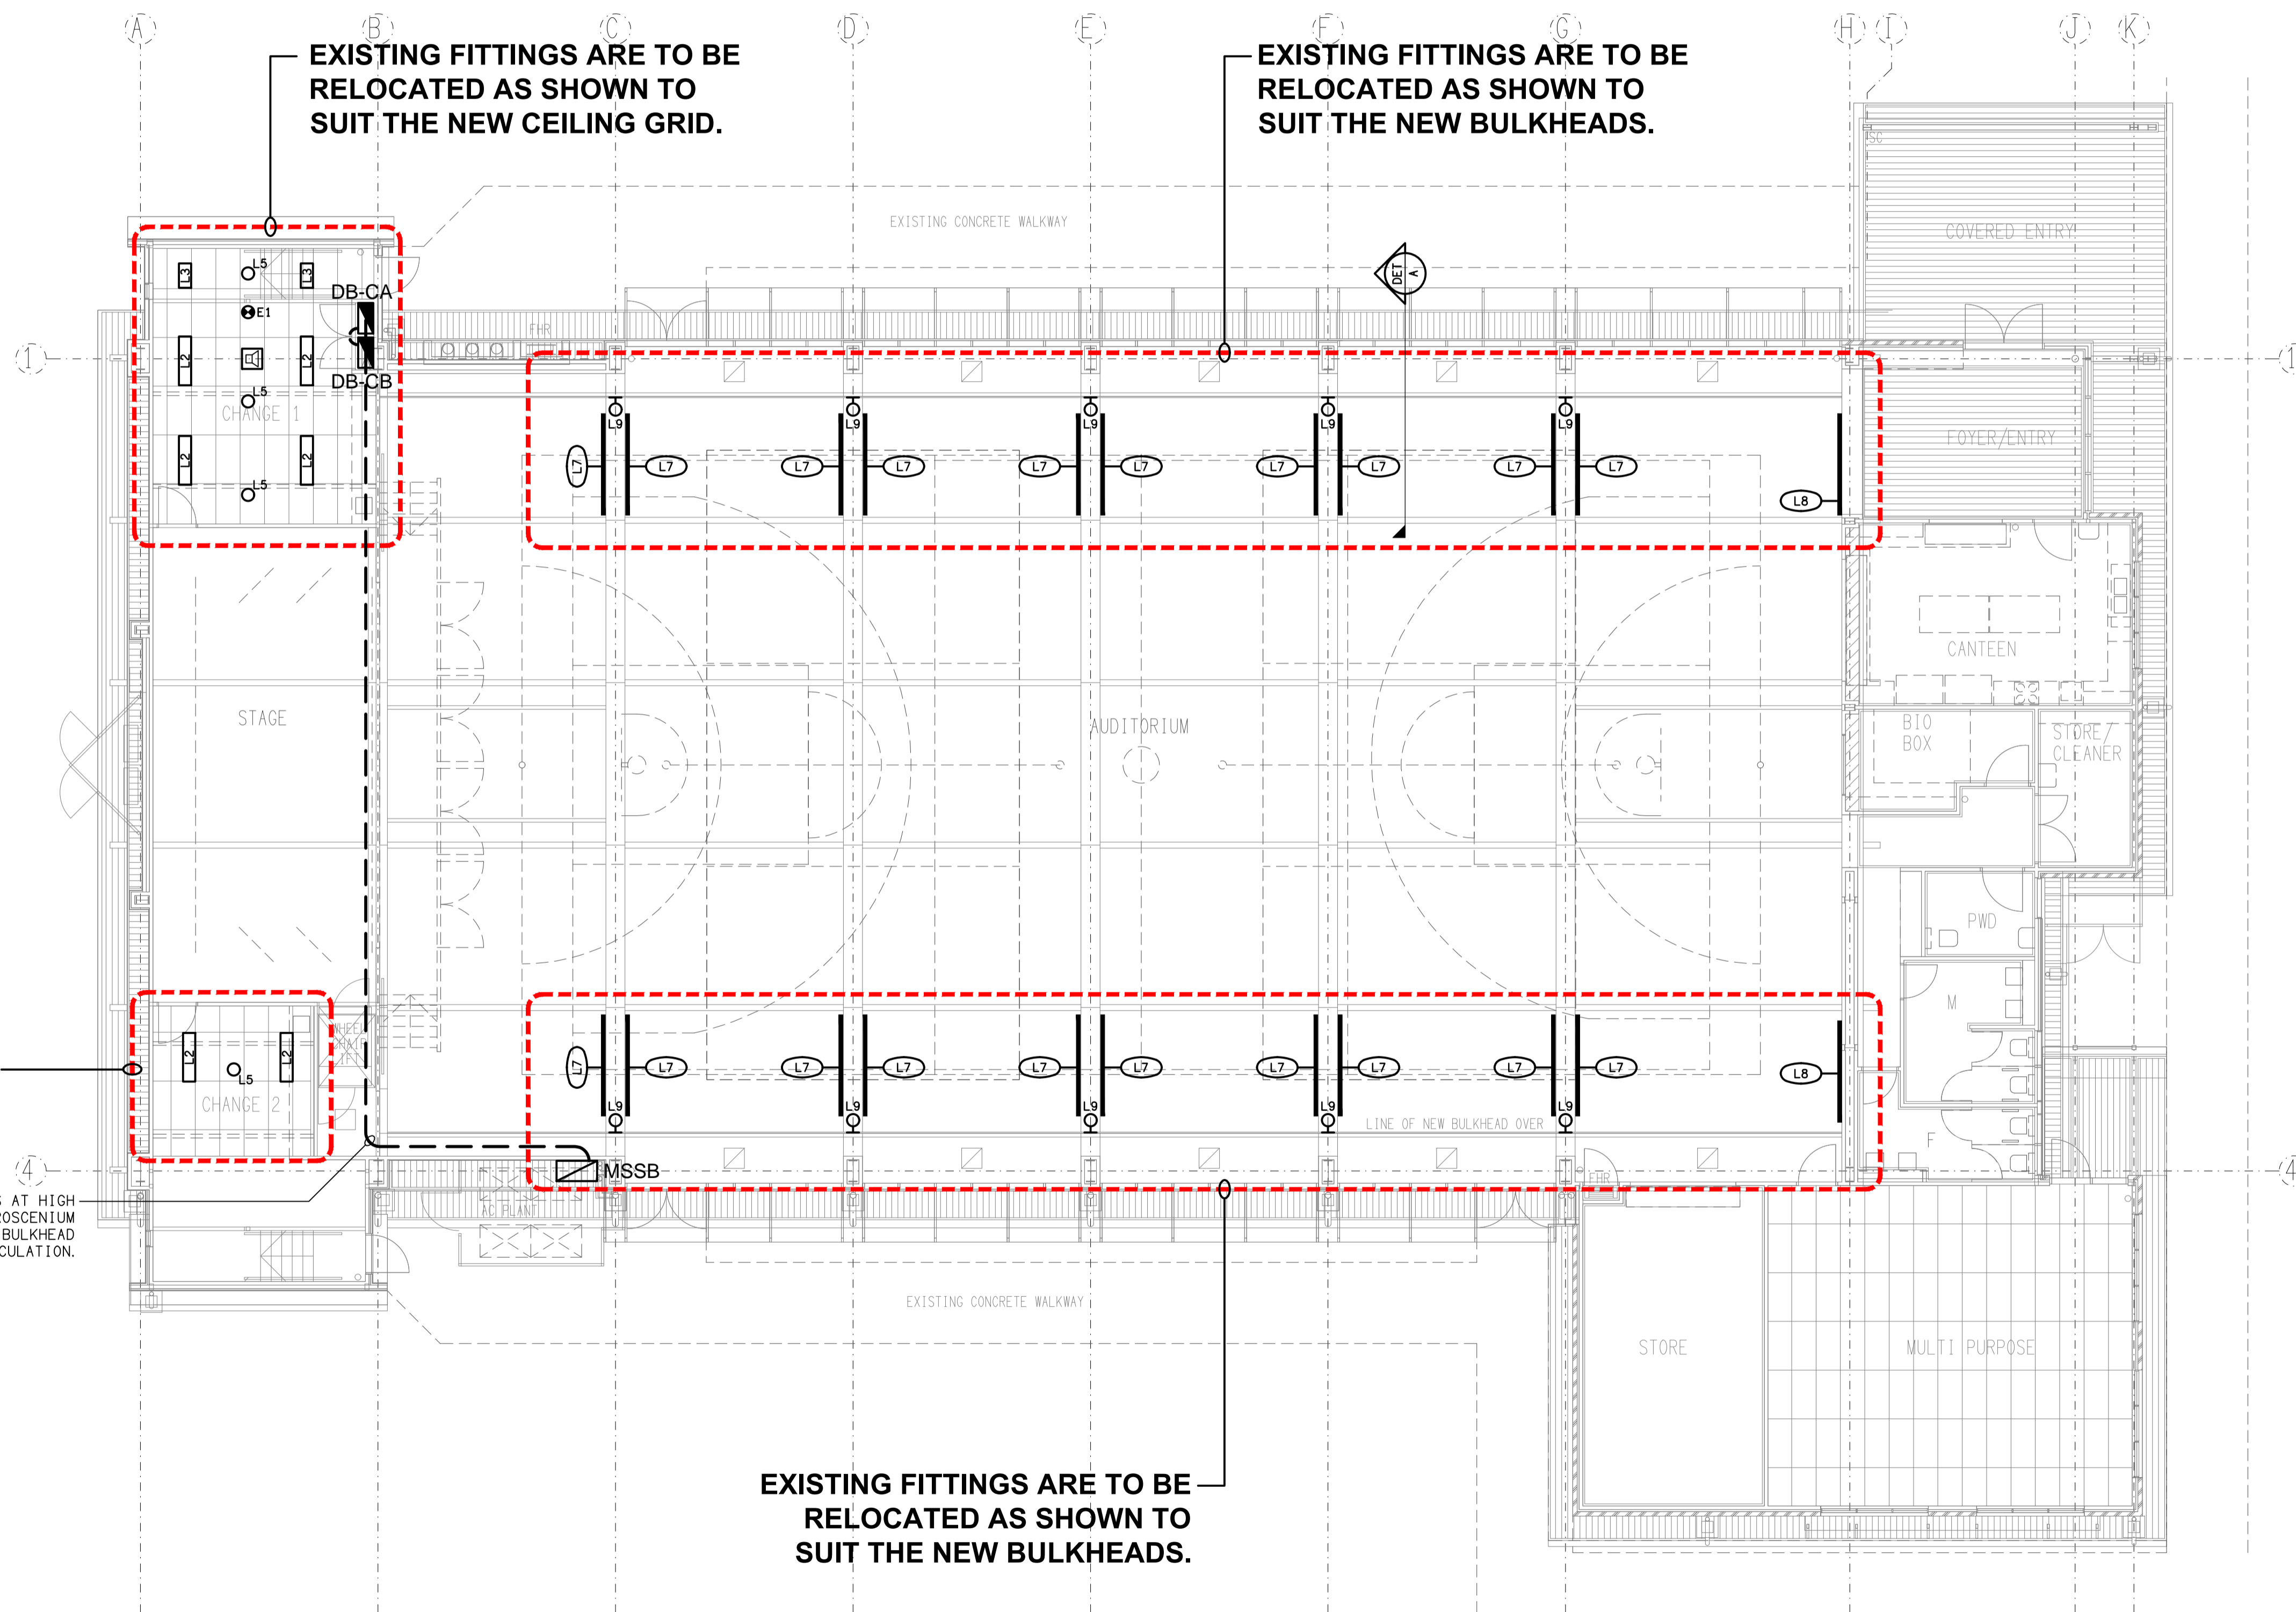
EXISTING FITTINGS ARE TO BE RELOCATED AS SHOWN TO SUIT THE NEW CEILING GRID.

RUN MSSB SUBMAINS AT HIGH LEVEL BEHIND PROSCENIUM OPENING AND IN NEW BULKHEAD WITH AC PIPEWORK RETICULATION.

EXISTING FITTINGS ARE TO BE RELOCATED AS SHOWN TO SUIT THE NEW CEILING GRID.

EXISTING FITTINGS ARE TO BE RELOCATED AS SHOWN TO SUIT THE NEW BULKHEADS.

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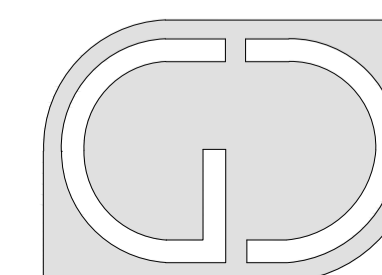
REV	DATE	DESCRIPTION
C	11/03/2020	TENDER

ELECTRICAL DESIGN GROUP
ELECTRICAL BUILDING SERVICES CONSULTANTS
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CLIENT
THE ROMAN CATHOLIC TRUST CORPORATION FOR THE DIOCESE OF TOWNSVILLE

PROJECT
ST CLARE'S CATHOLIC SCHOOL
MULTI-PURPOSE HALL AC
BURDELL DRIVE, THURINGOWA

DRAWING TITLE
ELECTRICAL SERVICES REFLECTED CEILING PLAN



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DATE
SCALE 1:100 UNO A1
DRAWN
CHECKED

C2189a
EDG PROJECT No.
E03 C
EDG DWG No. REV