


THE MAJORITY OF THE ELECTRICAL SERVICES SHOWN ON THIS DRAWING HAVE BEEN REVISED AT THIS REVISION (B).

LOCATE THE POWER SUPPLY FOR THE LIFT AS PER THE LOCATION NOMINATED IN THE LIFT SHOP DRAWINGS. SHAFT ENTRY TO BE APPROXIMATELY 200mm BELOW TOP FLOOR LEVEL AND WITHIN 50mm OF THE CORNER OF SHAFT AS INDICATED IN DRAWING. AFTER ENTRY INTO THE LIFT SHAFT, LEAVE APPROXIMATELY 4M CABLE TAIL AND TERMINATE CABLE INTO 3-PHASE, 32AMP OUTLET (CLIPSAL CAT No. 56P0532 OR EQUAL) AND SUSPENDED OUTSIDE THE TOP FLOOR ENTRANCE FOR EASY ACCESS.

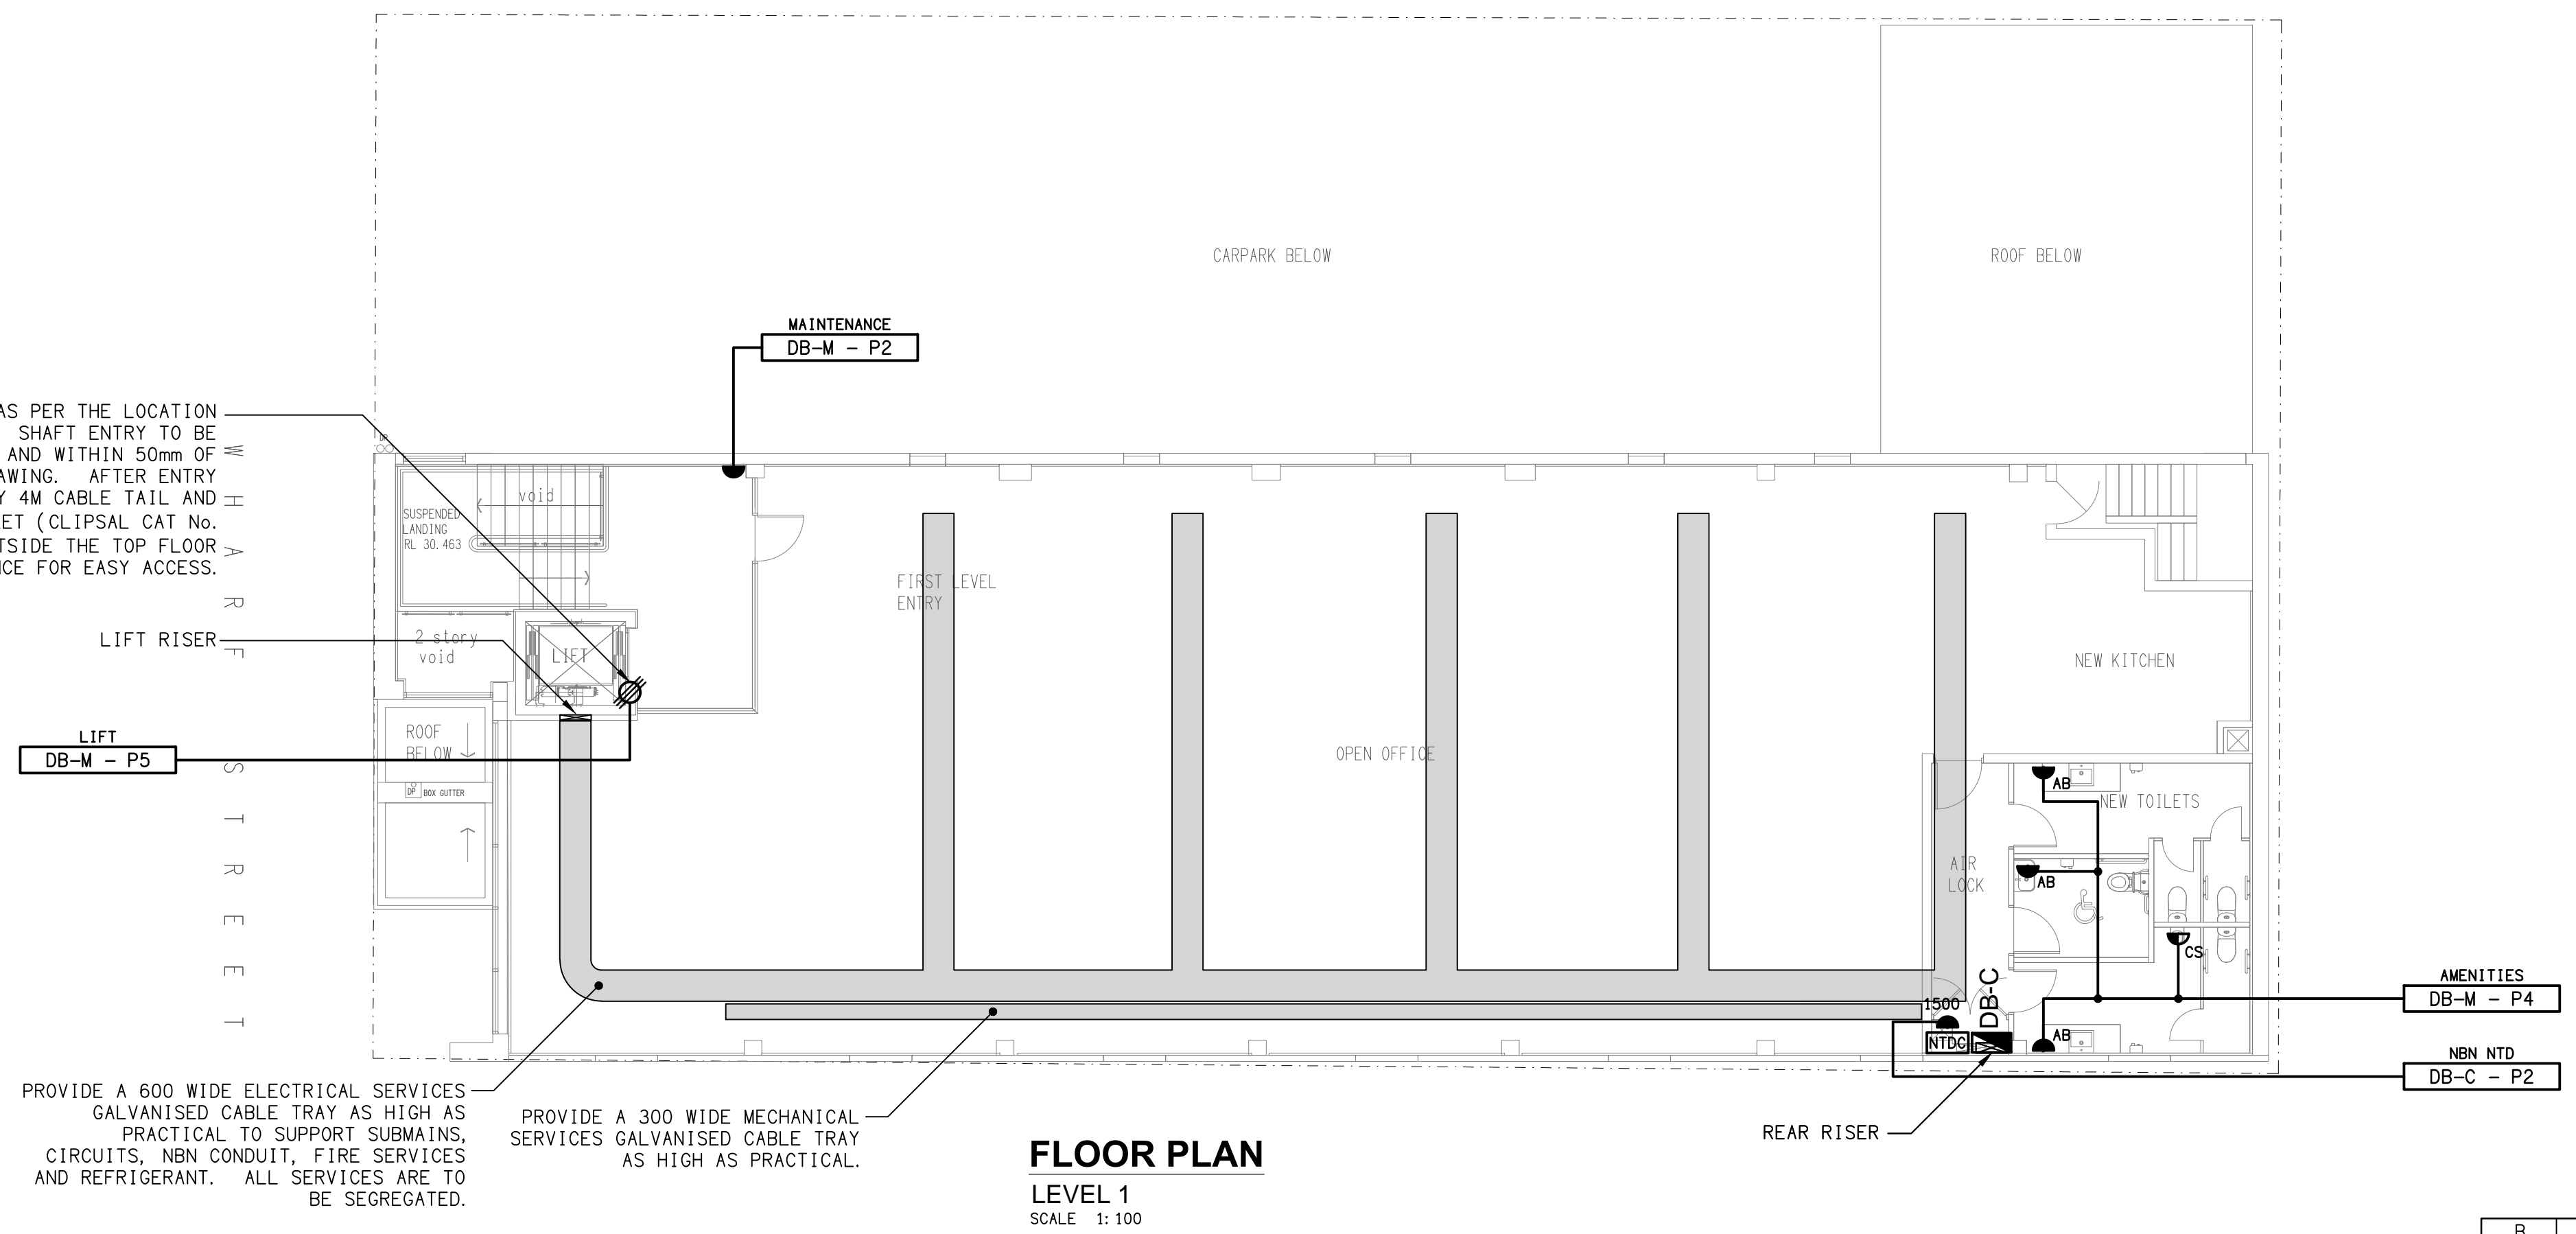

PROVIDE A 600 WIDE ELECTRICAL SERVICES GALVANISED CABLE TRAY AS HIGH AS PRACTICAL TO SUPPORT SUBMANS, CIRCUITS, NBN CONDUIT, FIRE SERVICES AND REFRIGERANT. ALL SERVICES ARE TO BE SEGREGATED.

PROVIDE A 300 WIDE MECHANICAL SERVICES GALVANISED CABLE TRAY AS HIGH AS PRACTICAL.

ELECTRICAL DESIGN GROUP BRISBANE PTY LTD  
ACN 092 710 793  
TRADING AS:  
ELECTRICAL DESIGN GROUP

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USE FIGURED DIMENSIONS IN PREFERENCE TO SCALE.  
ALL DIMENSIONS TO BE VERIFIED ONSITE.

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PROJECT:  
143 WHARF STREET, SPRING HILL  
BRISBANE

B	TENDER	21/04/2023
REV:	DESCRIPTION:	DATE:
DRAWING: <b>ELECTRICAL SERVICES</b> <b>LEVEL 1</b> <b>FLOOR PLAN &amp; REFLECTED CEILING PLAN</b>		
SCALE: 1:100	PROJECT NO: <b>C3017a</b>	DRAWING NO: <b>E04</b>
AT A1	REVISION: <b>B</b>	