
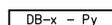


LEGEND

-  ELECTRICAL SERVICES SWITCHBOARD.
-  CAT-6 RJ45 OUTLET IN BUILDING 2 CABLED TO A CAT-6 RJ45 OUTLET IN BUILDING 3 VIA AN EXTERNAL GEL FILLED CAT 6 CABLE VIA THE NEW UNDERGROUND PIT AND CONDUIT SYSTEM.
-  DOUBLE 10 AMP POWER OUTLET EQUAL TO CLIPSAL WHITE 2000 SERIES MOUNTED AT 300 AFFL UNO.
-  DOUBLE 10 AMP POWER OUTLET EQUAL TO CLIPSAL WHITE 2000 SERIES MOUNTED AT 300 AFFL IN A CLIPSAL 255 HOUSING UNO.
-  SINGLE POWER OUTLET EQUAL TO CLIPSAL WHITE 2000 SERIES 10 AMP UNO. MOUNTED AT 300 AFFL UNO.
-  THREE PHASE IP66 20 AMP ISOLATOR CONNECTED TO THE EQUIPMENT VIA A FLEXIBLE SMOOTH CONDUIT. MOUNTED AT 1000 AFFL UNO.
-  SINGLE PHASE IP66 32 AMP ISOLATOR CONNECTED TO THE EQUIPMENT VIA A FLEXIBLE SMOOTH CONDUIT. MOUNTED AT 1000 AFFL UNO.
-  32 AMP SWITCH TO CONTROL THE COOK TOP. EQUAL TO CLIPSAL WHITE 2000 SERIES. MOUNTED ON OR ADJACENT THE ABOVE BENCH GPO.
-  TWO WAY LIGHT SWITCH EQUAL TO CLIPSAL WHITE 2000 SERIES. MOUNTED AT 1000 AFFL UNO.
-  TWO WAY IP66 LIGHT SWITCH. MOUNTED AT 1000 AFFL UNO.
-  CIRCUIT LINE.
-  SWITCH LINE.
-  POWER CIRCUIT DESIGNATION. DENOTES DB AND CIRCUIT.
-  E1: RECESSED NON MAINTAINED EMERGENCY LIGHT EQUAL TO CLEVERTRONICS LLIFE
-  EX: MAINTAINED EXIT LIGHT EQUAL TO CLEVERTRONICS CSBLED. CEILING SURFACE MOUNT OR WALL MOUNT BETWEEN 2100mm & 2700mm AFFL IF THERE IS NO VERTICAL SURFACE TO MOUNT THE FITTING ON WITHIN THIS RANGE CONFIRM THE MOUNTING HEIGHT WITH THE ENGINEER.
-  L1: 1200 SURFACE MOUNTED IP65 4000K LED BATTEN C/W INTEGRAL DRIVER. EQUAL TO MELEC ML-MRWPB-120-M
-  L2: 300 X 1200 SURFACE MOUNTED 4000K LED FLAT PANNEL TROFFER C/W REMOTE DRIVER. EQUAL TO MELEC MRBPV3-12X3-M + ML-UNI-12x3-SMT
-  L3: RECESSED 4000K IP54 LED DOWNLIGHT C/W REMOTE DRIVER. EQUAL TO MELEC ML-MR13-MULTI-XC.

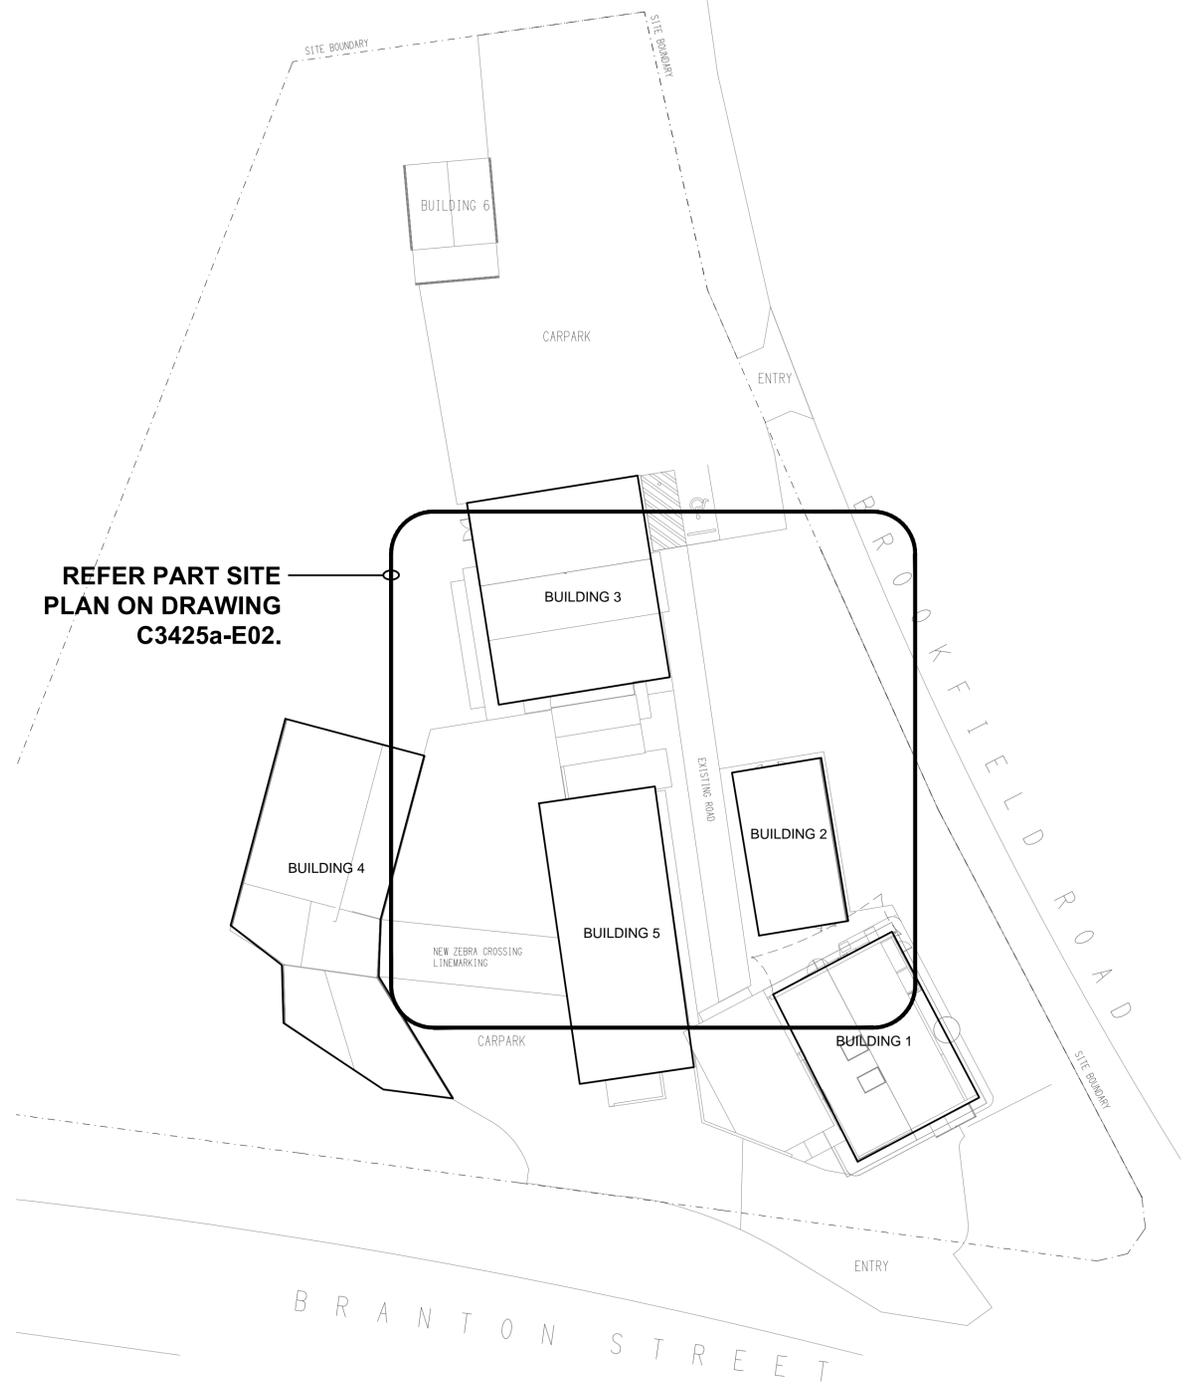

OVERALL SITE PLAN
 KENMORE COMMUNITY CENTRE UPGRADES
 SCALE 1:250

ELECTRICAL DESIGN GROUP BRISBANE
 PTY LTD
 ACN 092 710 793
 TRADING AS:
 ELECTRICAL DESIGN GROUP

THE COPYRIGHT OF THIS DRAWING
 REMAINS THE PROPERTY OF THE
 ELECTRICAL DESIGN GROUP.
 USE FIGURED DIMENSIONS
 IN PREFERENCE TO SCALE.
 ALL DIMENSIONS TO BE
 VERIFIED ONSITE.

ELECTRICAL DESIGN GROUP
 ELECTRICAL BUILDING SERVICES CONSULTANTS
 BRISBANE GOLD COAST
 P.O.Box 15, Sherwood Q.4075
 Phone: (07) 3278 4375
 Email: brisbane@edg.net.au
 Web: www.edg.net.au

PROJECT:
KENMORE COMMUNITY CENTRE
 98 BROOKFIELD ROAD, KENMORE HILLS

B	PRELIMINARY	18/12/2024
REV:	DESCRIPTION:	DATE:
DRAWING: ELECTRICAL SERVICES LEGEND & OVERALL SITE PLAN		
SCALE: 1:250	AT A1	PROJECT NO: C3425a
		DRAWING NO: E01
		REVISION: B